

September 11, 2025

Upper Leon MWD Intermediate Pump Station Improvements

Addendum No. 1

Attention is called to the following modifications to the referenced Plans, Specification and Contract Documents for the above-referenced project. Upper Leon Municipal Water District will receive sealed Proposals for the Intermediate Pump Station Improvements Project at the **Upper Leon Municipal Water District Office** located at **2250 Hwy 2861**, **Comanche**, **Texas 76442**, until <u>Tuesday</u>, <u>September 16th</u>, <u>2025</u>, at <u>2:00 p.m.</u> local time. We hereby modify the documents as follows:

SPECIFICATIONS:

- 1. Section 11311 Vertical Turbine Pumps
 - a. **ADD** Flowserve to "2.1 ACCEPTABLE MANUFACTURERS" list.
- 2. Section 16483 Variable Frequency Drive
 - a. ADD LS Electric to "2.1 ACCEPTABLE MANUFACTURERS" list.

PLANS:

- 1. **REPLACE** drawing sheet no. M-02 *Intermediate Pump Station Demolition Plan and Details* in its entirety with the attached.
- 2. **REPLACE** drawing sheet no. M-03 *Intermediate Pump Station Plan and Sections* in its entirety with the attached.
- 3. **REPLACE** drawing sheet no. M-04 *Intermediate Pump Station Plan and Sections* in its entirety with the attached.
- 4. **REPLACE** drawing sheet no. E-01 *Intermediate Pump Station Electrical Plans and Details* in its entirety with the attached.

Clarification:

- 1. Contractor to Coordinate SCADA Implementation with Garry Gattis Quality Electric Controls (903-243-1945) gwg@peoplescom.net.
- 2. The existing chemical equipment shown on Plan Sheets 6 & 7 is for information only. No scope for this system is included in the project.

- 3. The existing bladder tanks and tubing shown on Plan Sheet 6 are for information only. No scope for this system is included in the project.
- 4. To the greatest extent possible, one pump should remain in operation during improvements while the other pump is being replaced. Shutdown durations for the entire pump station are limited to 6 hours (per Plan Sheet 3) with as much advanced notice with operations as possible.
- 5. Handrail and toe board are not required for the landing.
- 6. Utilize the first available spare analog input and analog output in the existing RTU when connecting AO1 and AI2.

This addendum consists of **six** (6) sheet and becomes a part of the referenced contract documents and shall be acknowledged by the proposer and attached to the sealed proposal submitted.


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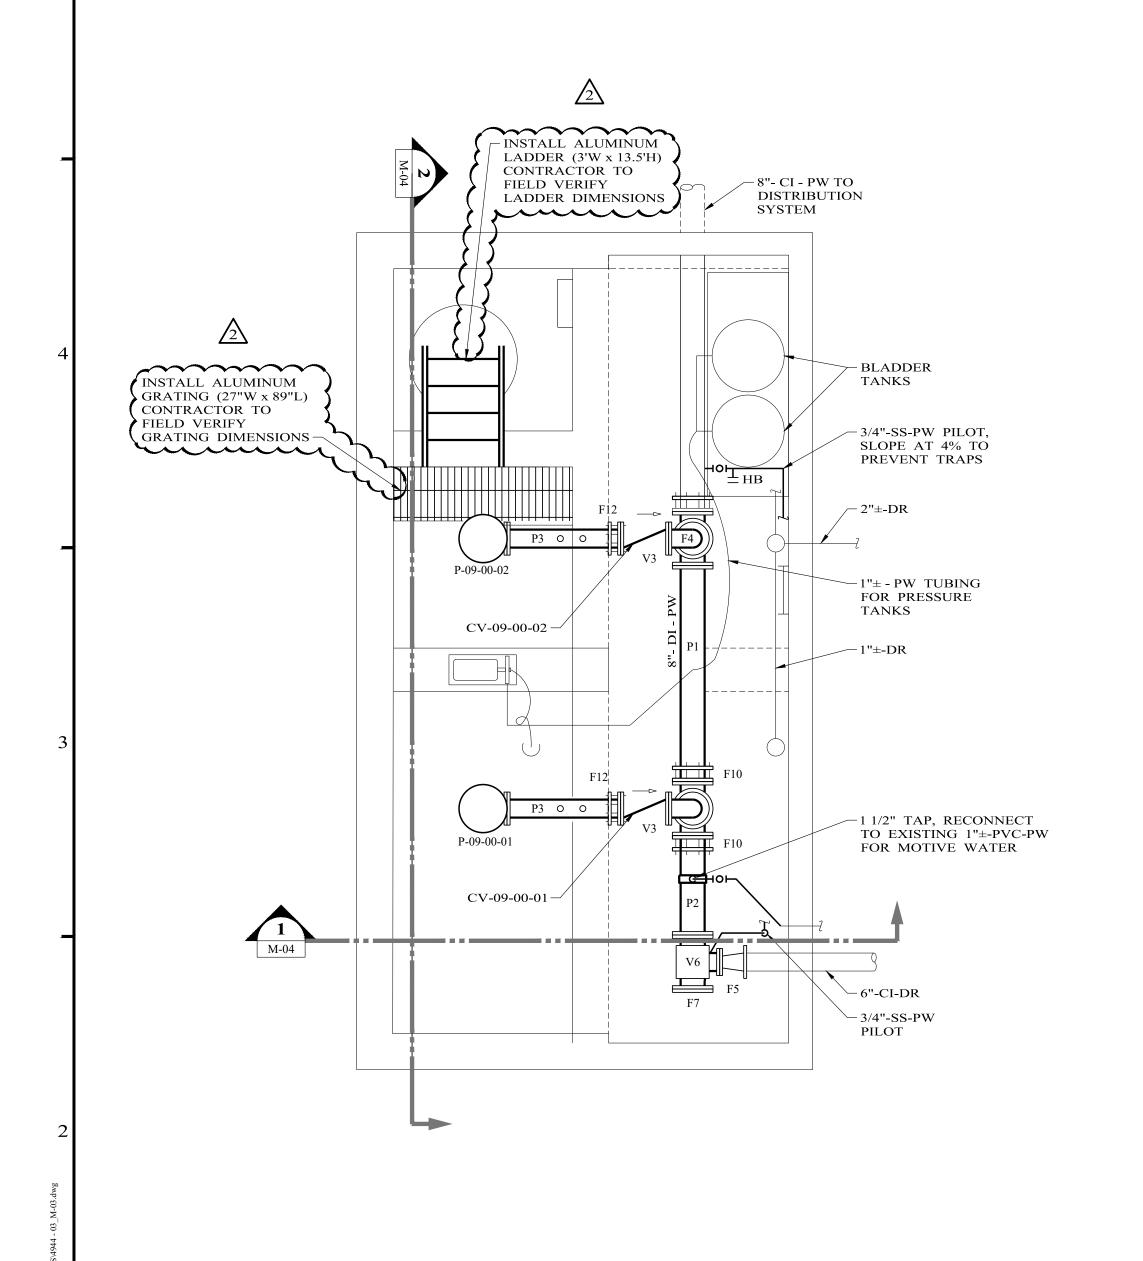
Brittany White, PE Project Manager

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BRITTANY D. WHITE

9/11/2025



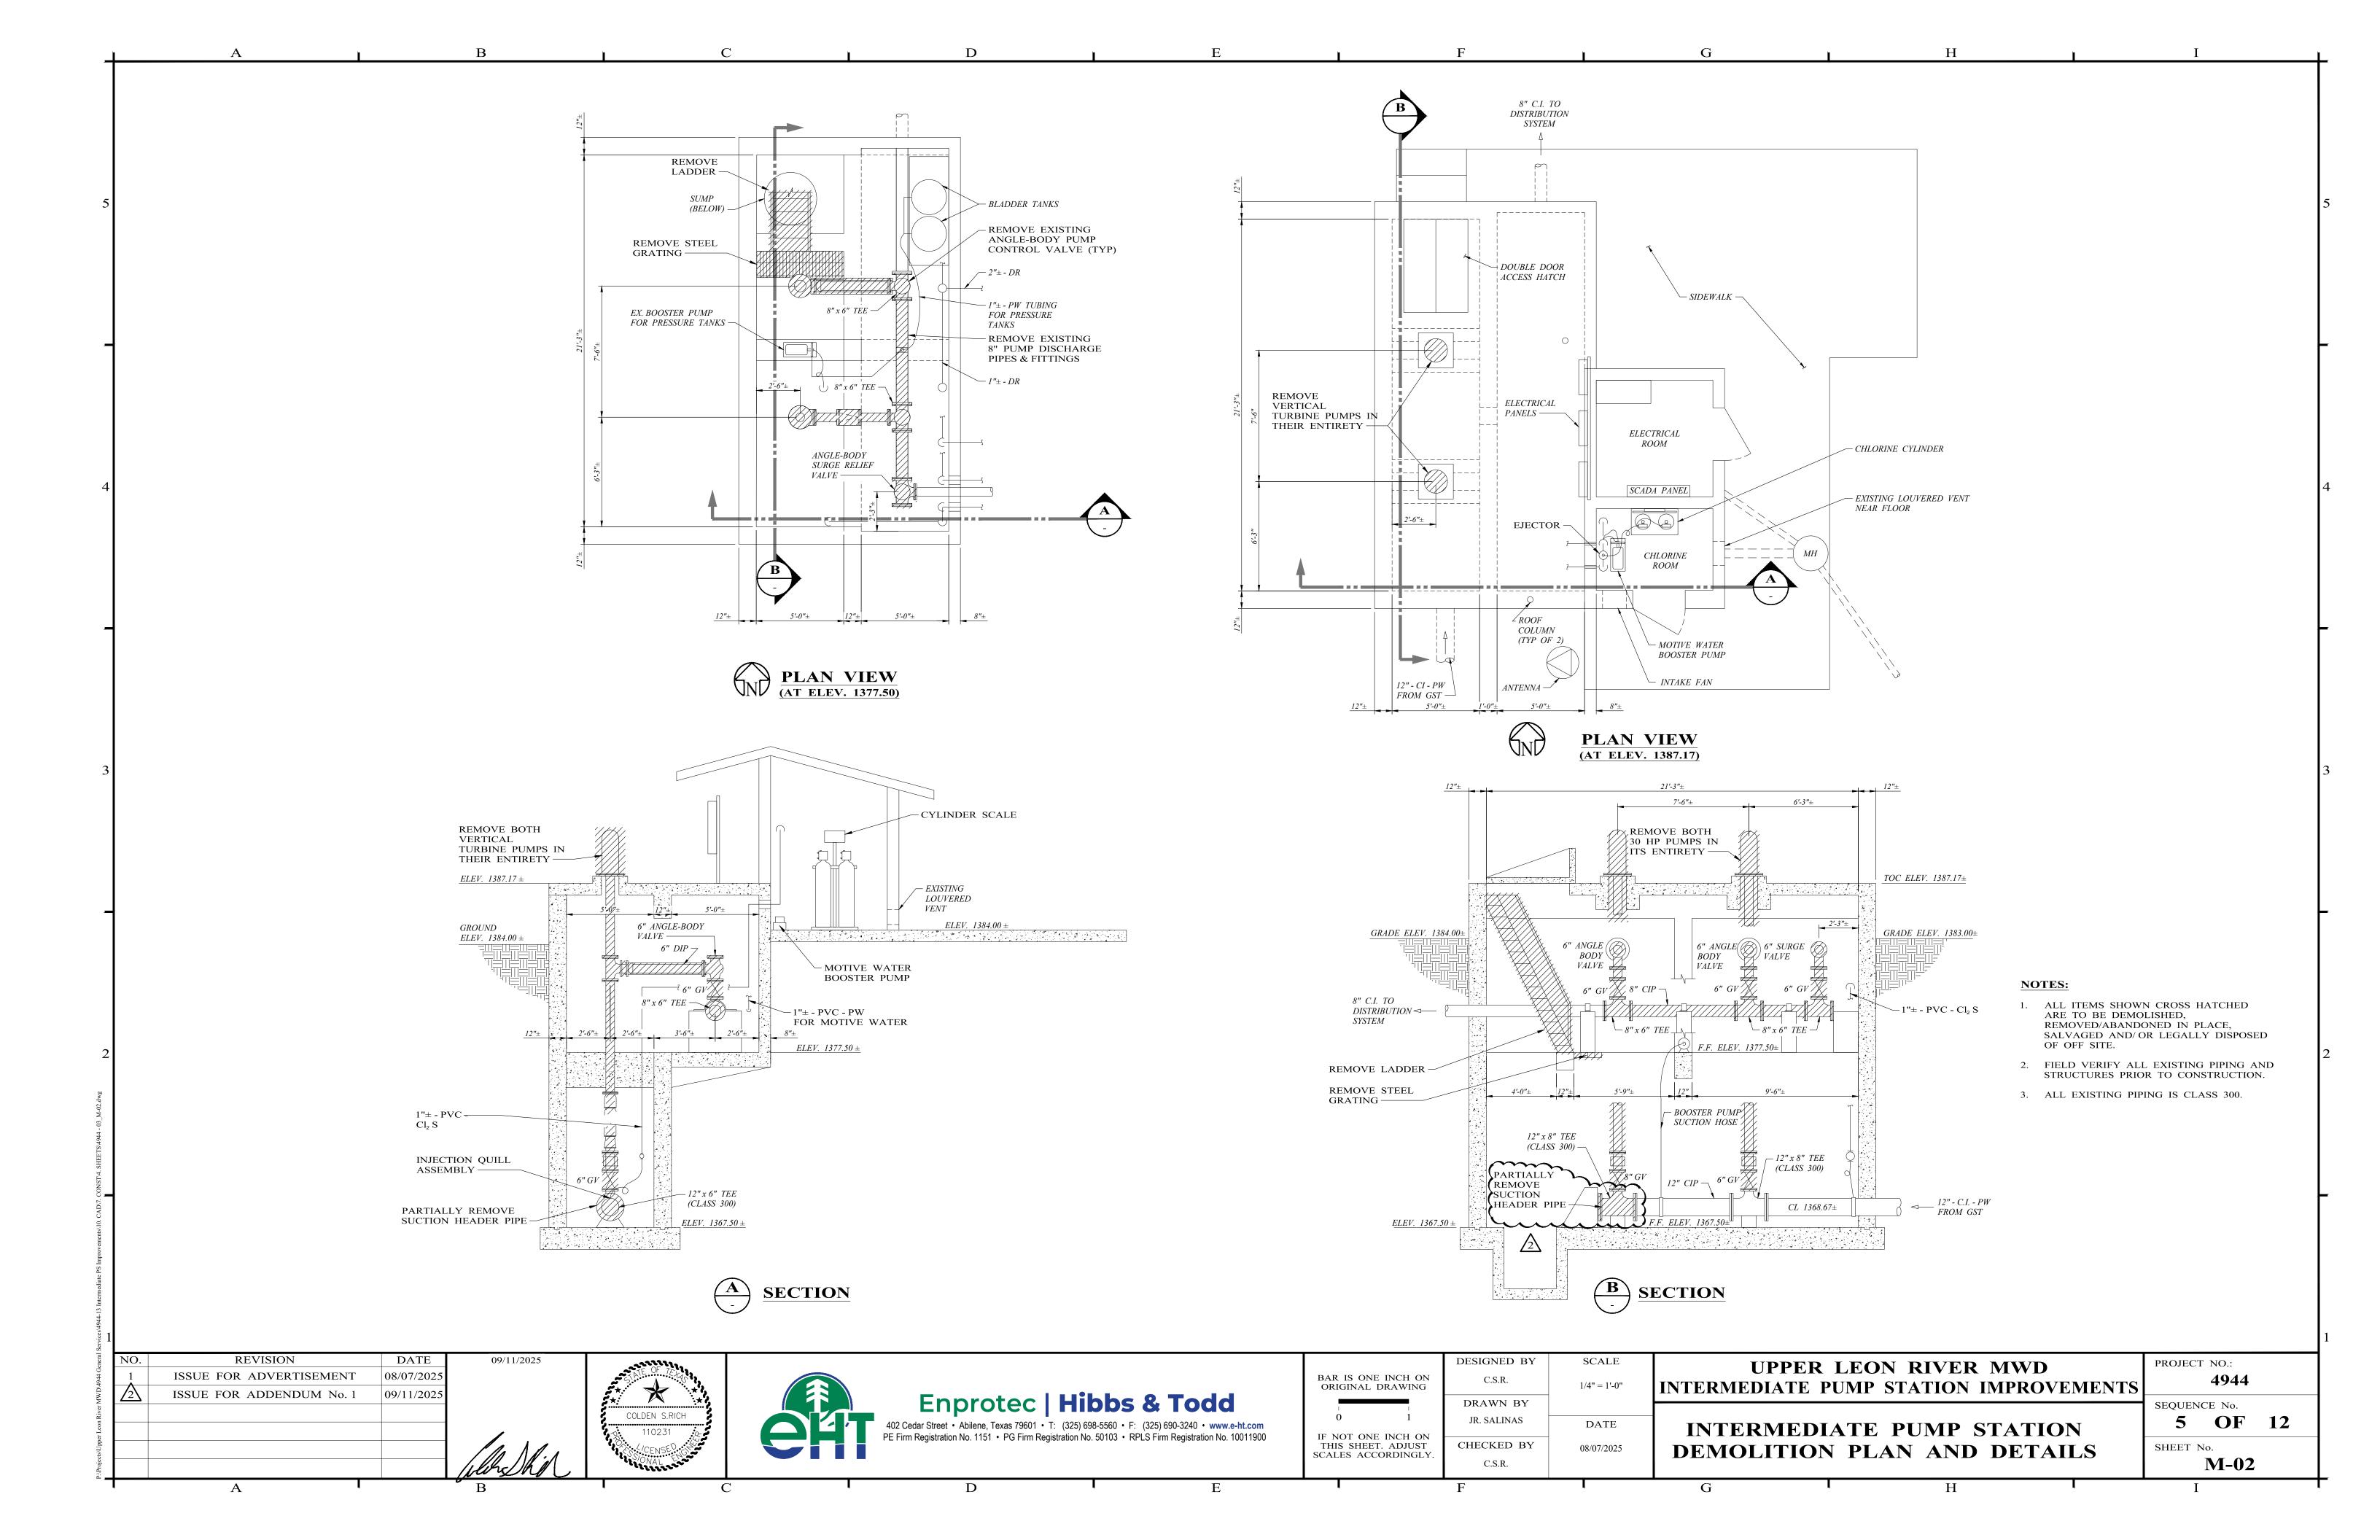


GENERAL NOTES:

- 1. FIELD VERIFY ALL EXISTING STRUCTURES PRIOR TO CONSTRUCTION.
- 2. NOT ALL PIPE SUPPORTS ARE SHOWN. PROVIDE PIPE SUPPORTS AT MAXIMUM SPACING LISTED IN SECTION 15090.



	PIPE SCHEDULE		
MARK	DESCRIPTION		
F2	8" x 3" DI FL TEE		
F3	8" x 6" DI FL TEE		
F4	6" DI 90° BEND		
F5	6" x 3" DI FL REDUCER		
F6	3" RFA		
F7	8" BLIND FLANGE		
F8	8" x 6" REDUCER		
F10	8" RFA		
F11	6" RFA		
F12	6" FL ADAPTER		
V1	6" FL BUTTERFLY VALVE		
V2	6" FL GATE VALVE		
V3	6" FL CHECK VALVE		
V4	6" PRESSURE GAUGE		
V5	1" AIR/VACUUM VALVE		
V6	3" FL SRV-09-00-01		
V7	3" FL GATE VALVE		
P1	8" DI SPOOL FL x PE		
P2	NOT USED		
Р3	6" DI SPOOL FL x PE		
P4	NOT USED		
P5	NOT USED		
P6	3" DI SPOOL FL x PE		

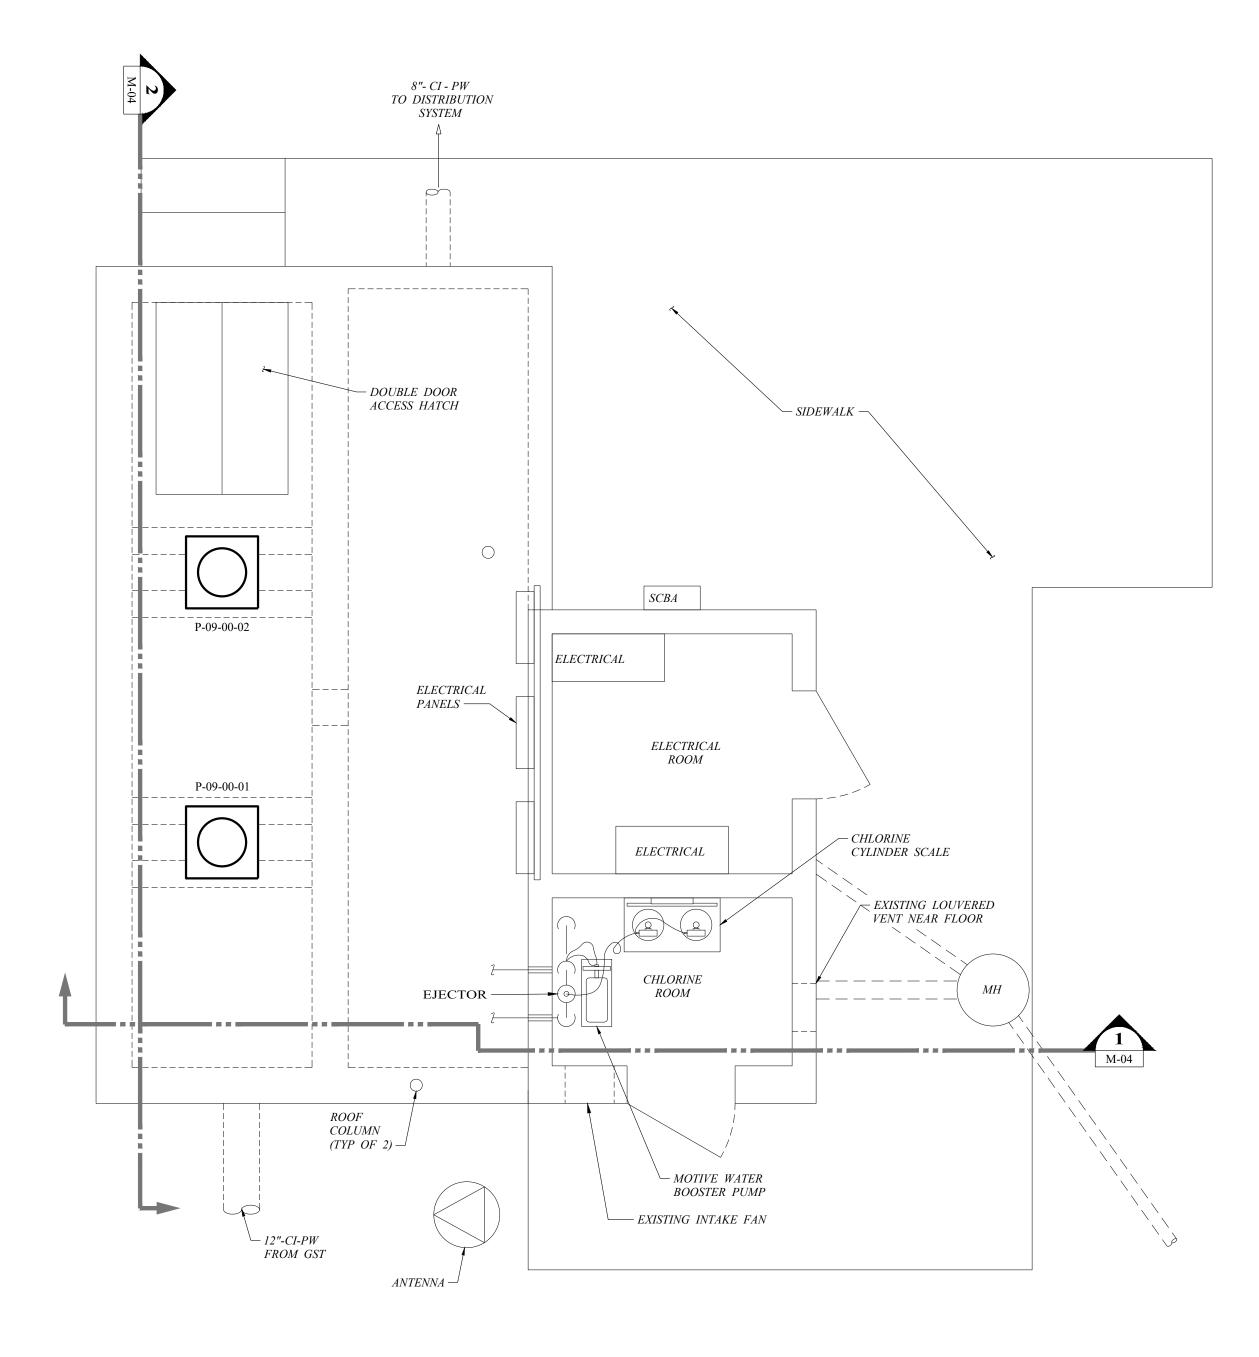



PLAN VIEW (AT ELEV. 1387.17)

PLAN VIEW (AT ELEV. 1377.50)

NO.	REVISION	DATE
1	ISSUE FOR ADVERTISEMENT	08/07/2025
<u>/</u> 2\	ISSUE FOR ADDENDUM No. 1	09/11/2025





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	DESIGNED BY	SCALE
AR IS ONE INCH ON ORIGINAL DRAWING	C.S.R.	1/4" = 1'-0"
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0 1	JR. SALINAS	DATE
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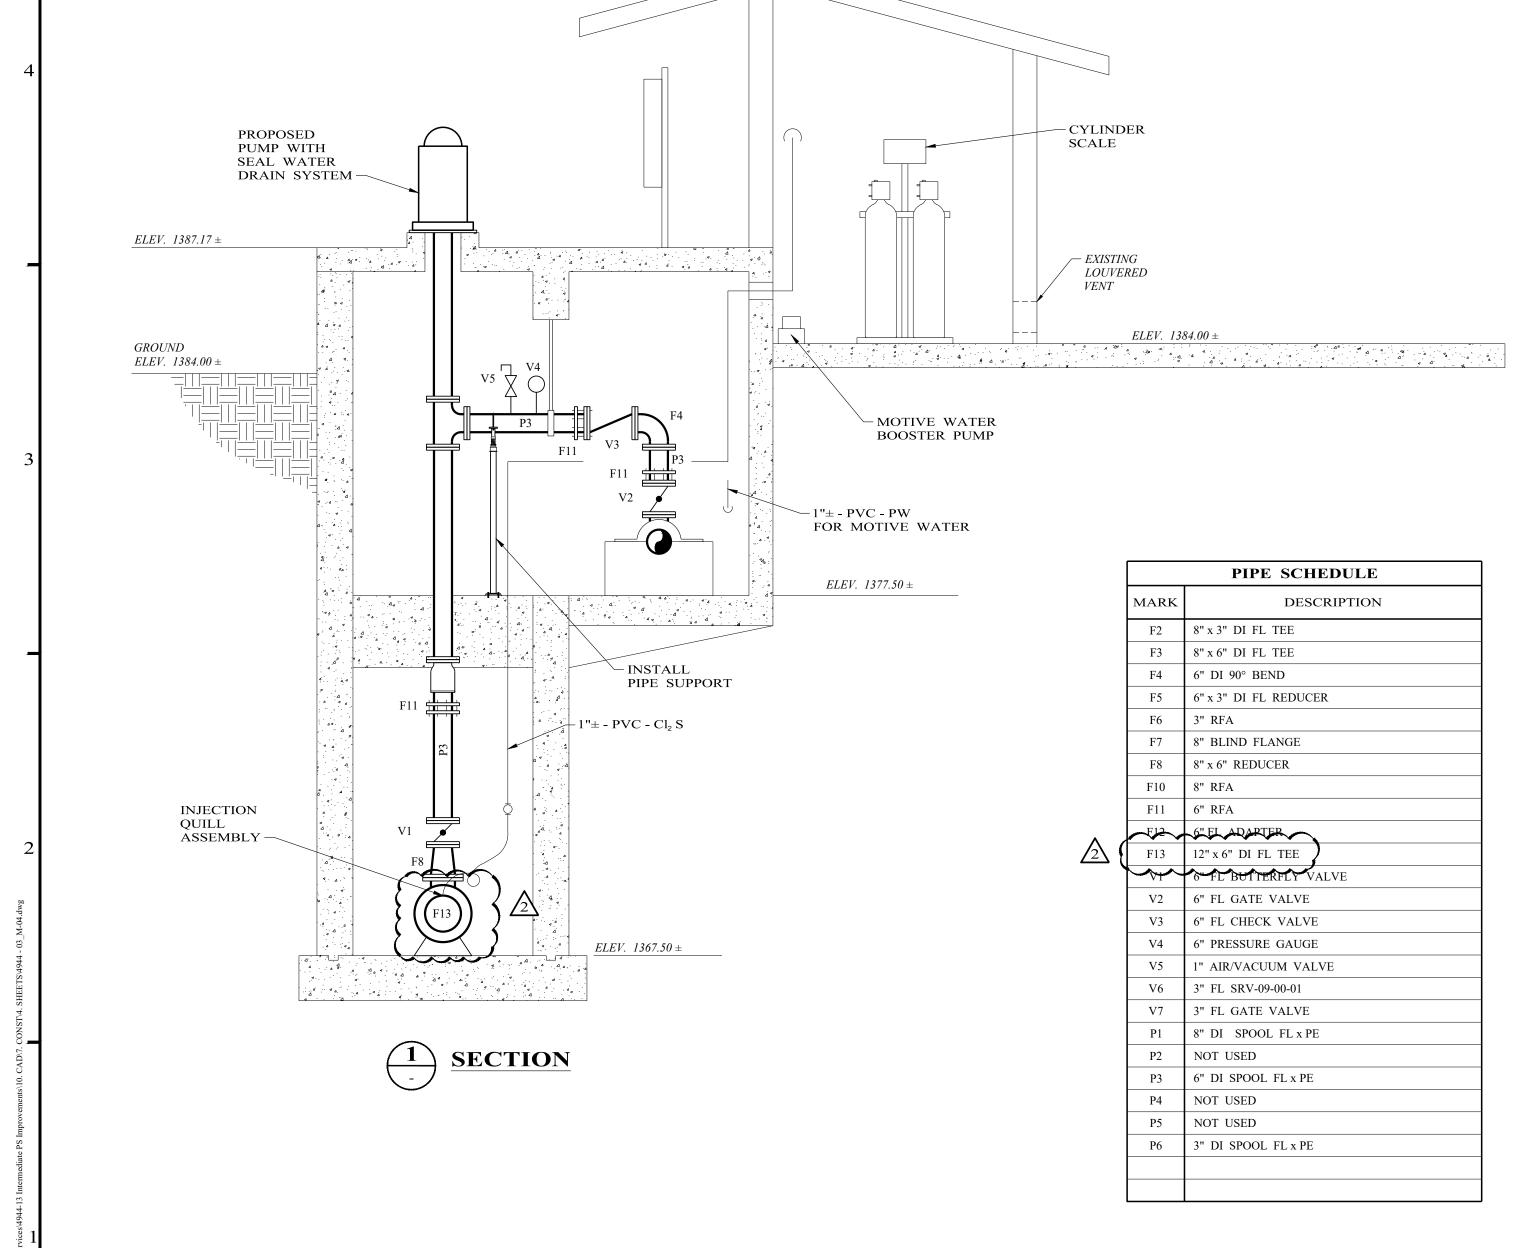
UPPER LEON RIVER MWD INTERMEDIATE PUMP STATION IMPROVEMENTS
INTERMEDIATE PUMP STATION


PLAN AND SECTIONS

	PROJECT NO.:	
NTS	4944	
	sequence no. 6 OF 1	2
	SHEET No. M-03	
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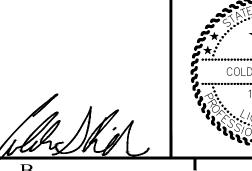
GENERAL NOTES:

- 1. FIELD VERIFY ALL EXISTING STRUCTURES PRIOR TO CONSTRUCTION.
- 2. NOT ALL PIPE SUPPORTS ARE SHOWN. PROVIDE PIPE SUPPORTS AT MAXIMUM SPACING LISTED IN SECTION 15090.
- 3. PCV-09-00-01 SHALL BE CLA-VAL 300# FLANGED GLOBE VALVE MODEL 60-11. MAIN VALVE SHALL BE DUCTILE IRON, EPOXY COATED, WITH SS TRIM. PROVIDE SOLENOID VALVE OPERATED PILOT FOR 120V POWER SUPPLY ENERGIZED TO OPEN THE SOLENOID.
- 4. FILL EXISTING PENETRATION AND CUT NEW BANDED PENETRATIONS (TYP).



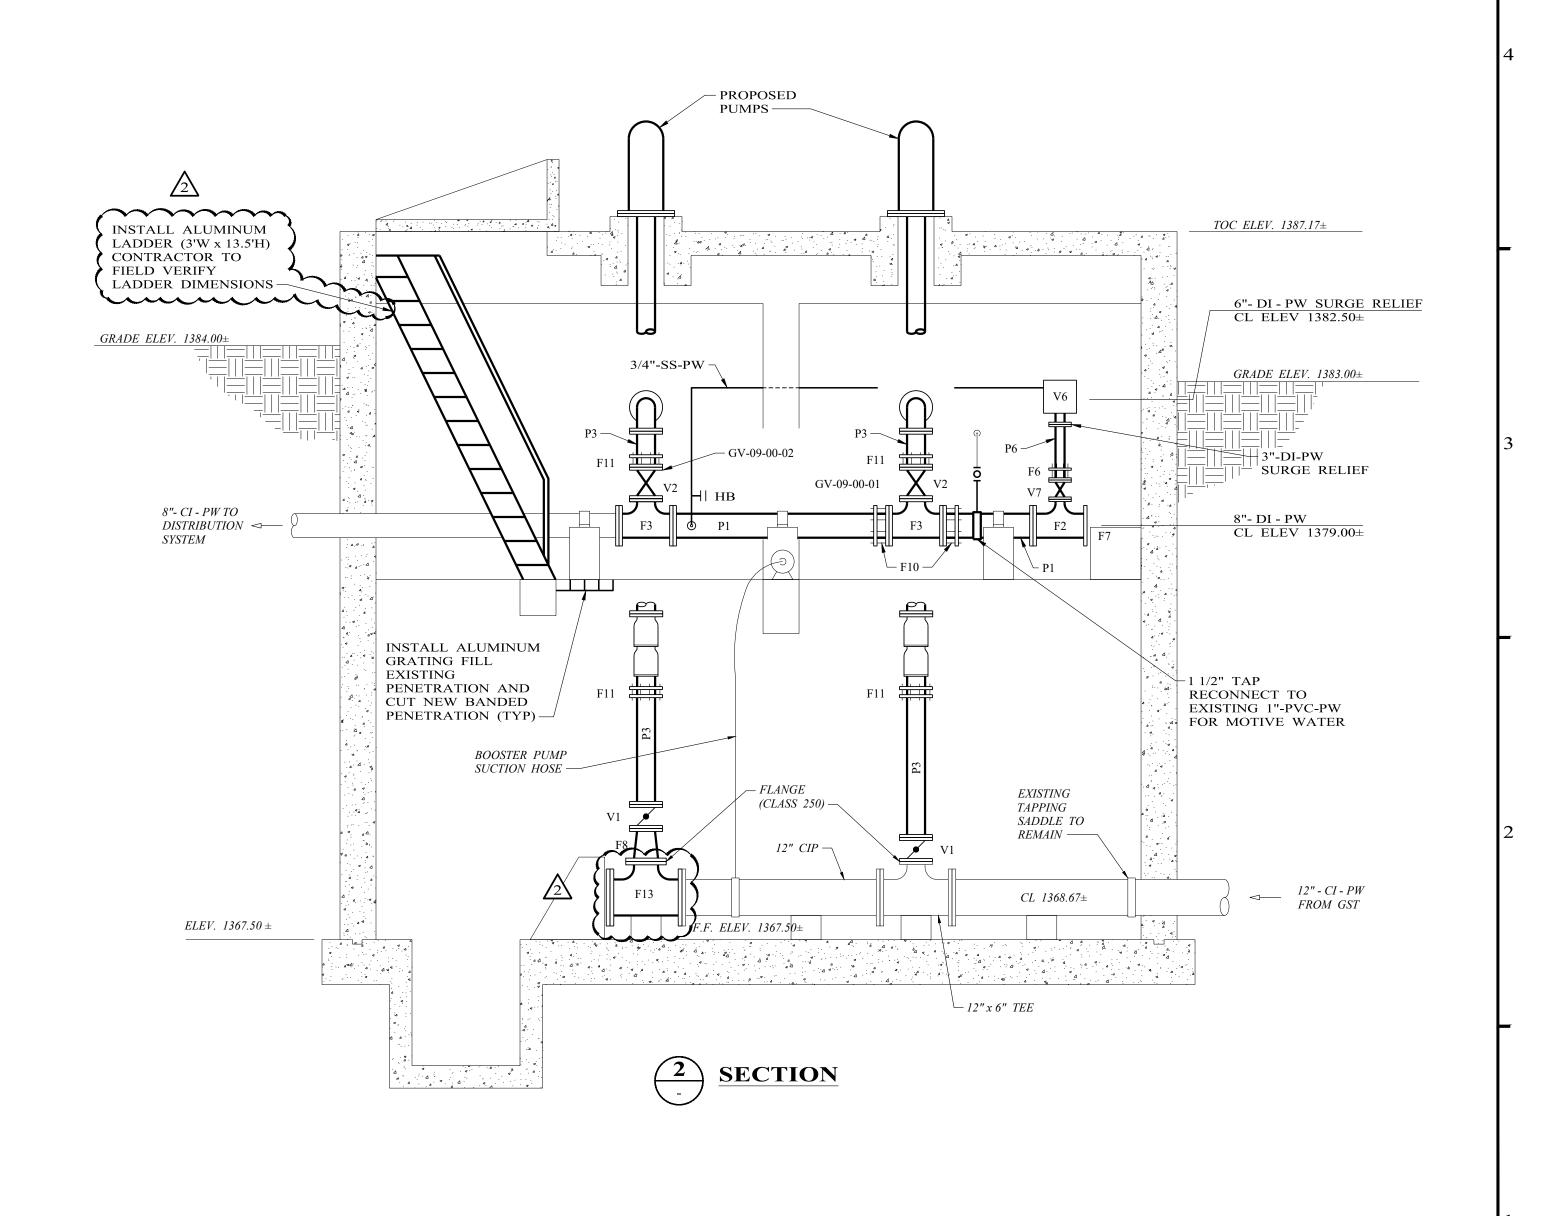

NO.	REVISION	DATE
1	ISSUE FOR ADVERTISEMENT	08/07/2025
2	ISSUE FOR ADDENDUM No. 1	09/11/2025





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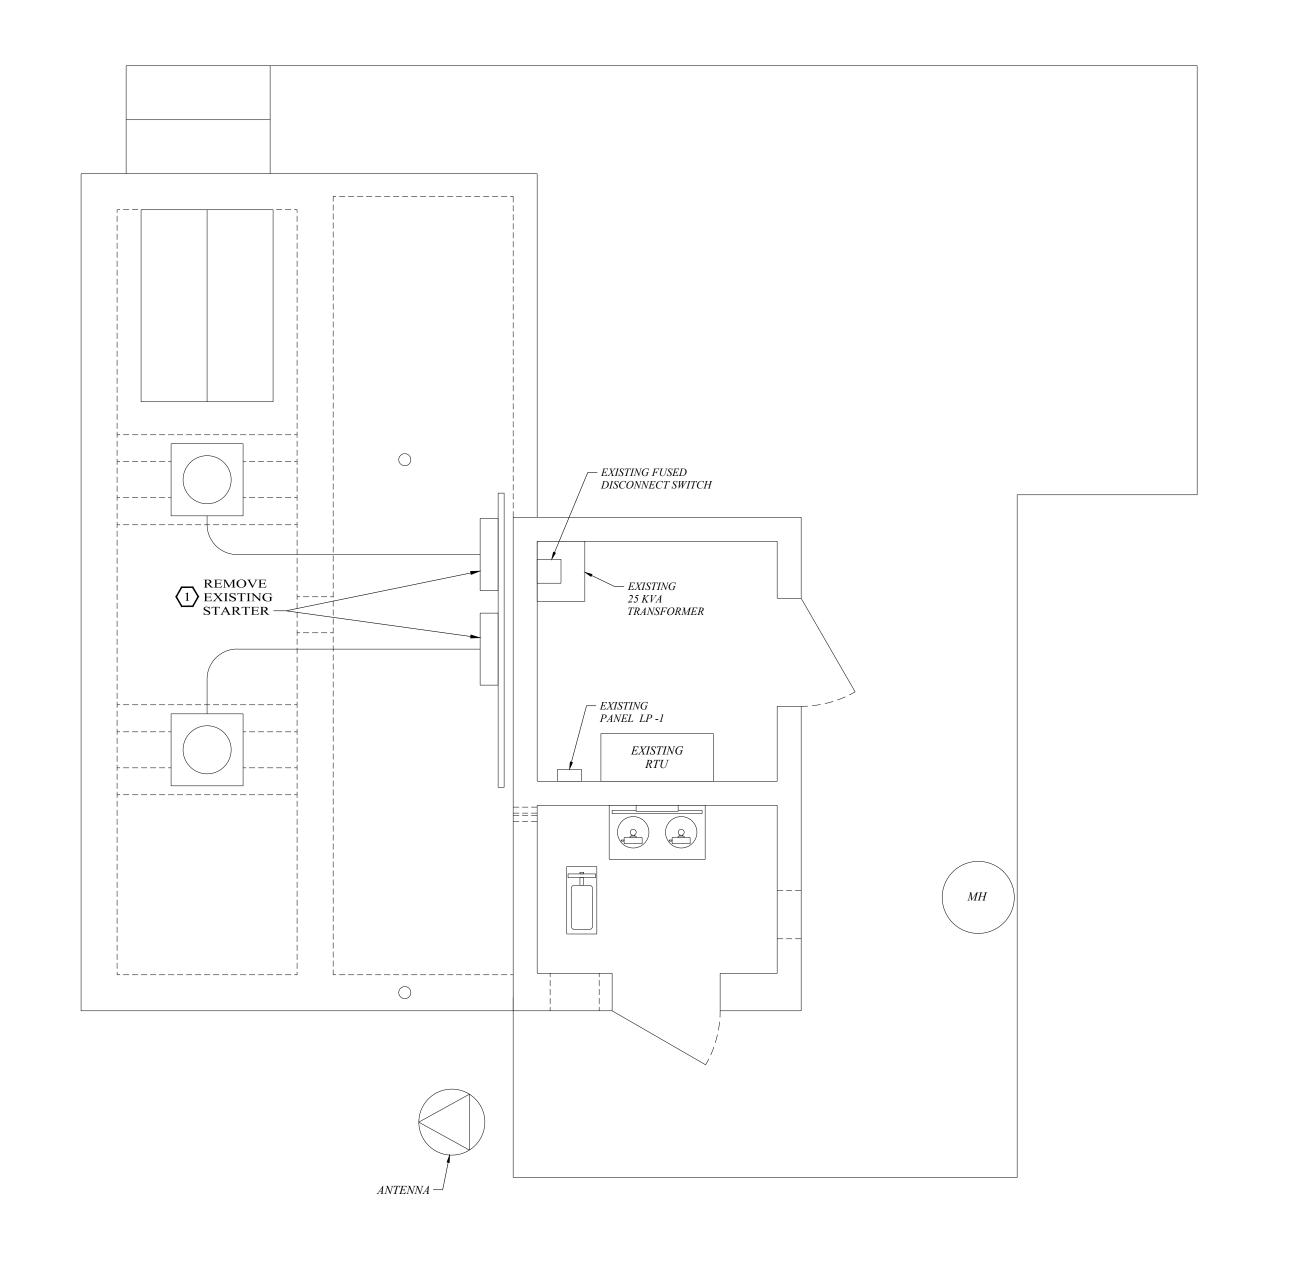
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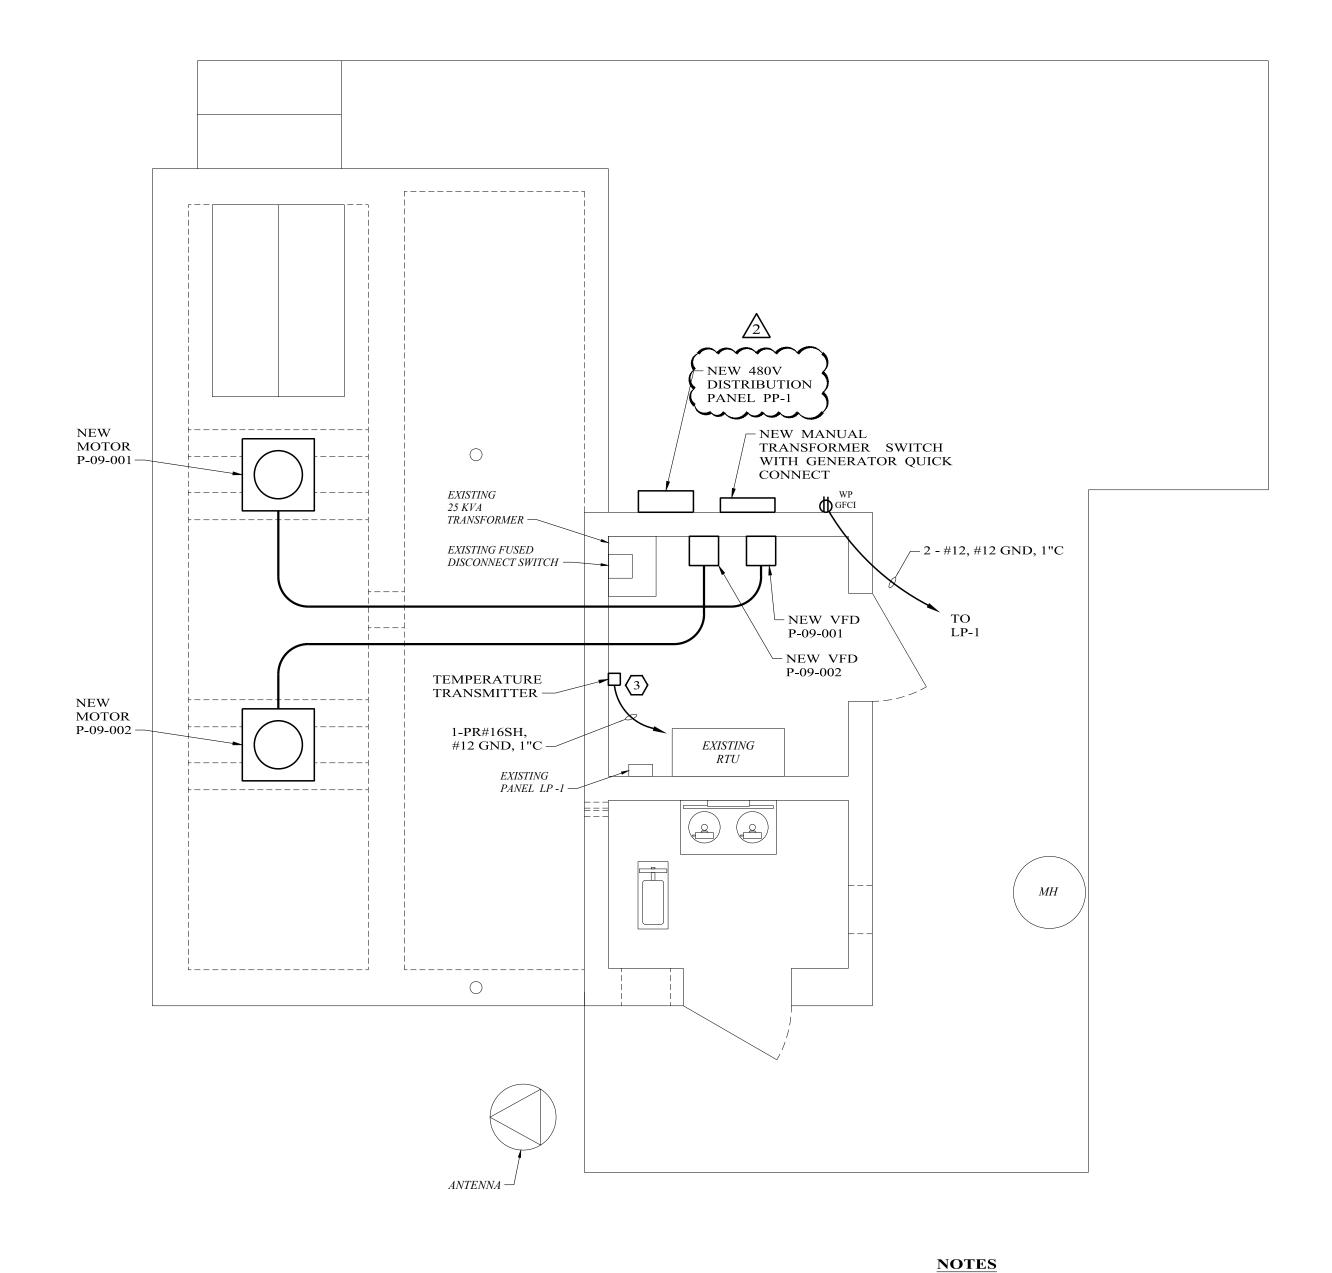
INTERMEDIATE PUMP STATION

PLAN AND SECTIONS

4944 SEQUENCE No. 7 OF 12 SHEET No. M-04

PROJECT NO.:









REVISED

- NECESSARY CONDUIT FOR A COMPLETE SYSTEM. 2. ALL EXPOSED CONDUIT TO BE RIGID ALUMINUM CONDUIT.
- 3. ALL EXTERIOR ELECTRICAL ENCLOSURES TO BE NEMA 3R.

1. NOT ALL CONDUITS MAY BE SHOWN, REFER TO CONDUIT

SCHEDULE AND SUBMITTED EQUIPMENT FOR ALL

- 4. ALL INTERIOR ELECTRICAL ENCLOSURES TO BE NEMA 3R.
- 5. ALL ELECTRICAL SUPPORTS AND HARDWARE TO BE 316SS.
- 6. PROVIDE LFNC FOR FINAL CONNECTION TO ALL ELECTRICAL EQUIPMENT SUBJECT TO VIBRATION AND INSTRUMENTS. MIN. & MAX PER SPECS.
- 7. PROPERLY GROUND MAIN PANEL PER ONE-LINE AND DETAILS.
- 8. PROVIDE ALUMINUM IN USE COVER FOR ALL OUTDOOR RECEPTACLES.
- 9. ALL DEVICE BOXES TO BE "FSD" CAST ALUMINUM.

10. PROPERLY SEAL ALL CONDUIT PENETRATIONS.

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1944 G	1	ISSUE FOR ADVERTISEMENT	08/07/2025	
con River MWD\4944 General Service	2	ISSUE FOR ADDENDUM No. 1	09/11/2025	
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PE Firm Registration No. 1151 • PG Firm Registration No. 50103 • RPLS Firm Registration No. 10011900

NOTES INDICATED ON DRAWING BY

2. REMOVE EXISTING JUNCTION BOX AND CONTROLS.

PROVIDE NEW AI CONTROLS FOR MONITORING.

JUNCTION BOX.

1. REMOVE THE EXISTING STARTERS AND ASSOCIATED CONDUIT AND CONDUCTORS TO THE MOTOR. REMOVE THE CONDUIT

AND CONDUCTORS FROM THE EXISTING STARTER TO THE

3. INSTALL NEW TEMPERATURE TRANSMITTER FOR MONITORING PUMP STATION ROOM TEMPERATURE TO EXISITNG RTU.

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SCALES ACCORDINGLY.	D.S.M.	

INTERMEDIATE PUMP STATION ELECTRICAL PLANS AND DETAILS

UPPER LEON RIVER MWD

INTERMEDIATE PUMP STATION IMPROVEMENTS

4944 SEQUENCE No. 10 OF 12 SHEET No. E-01

PROJECT NO.: