



December 31, 2025

**CITY OF KNOX CITY
TXCDBG PAVING AND DRAINAGE IMPROVEMENTS**

Addendum No. 3

Attention is called to the following modifications to the referenced Plans, Specification and Contract Documents for the above referenced project. The City of Knox City will receive sealed Bids for the Paving and Drainage Improvements project at City of Knox City, City Hall, located at 902 E. Main, Knox City, Texas 79529, until 1:30 p.m., local time on **Thursday, January 8, 2026**, at which time the sealed Bids received will be publicly opened and read. We hereby modify as follows:

BID DOCUMENTS

BID FORM:

1. **REPLACE** the Bid Form in its entirety with the attached Bid Form.

DRAWINGS:

1. **REPLACE** Drawing Sheets 8 and 12 with the attached Drawing Sheets 8 and 12.

This addendum consists of eleven (11) pages and becomes a part of the referenced plans, specifications and contract documents and shall be acknowledged by the proposer and attached to the sealed proposal submitted.

By: Sage Diller
Sage Diller, P.E. #96645
Project Manager



12/31/2025

City of Knox City
902 E. Main
Knox City, Texas 79529

Gentlemen:

The undersigned, as bidder, declares that the only person or parties interested in this proposal as principals are those named herein, that this proposal is made without collusion with any other person, firm, or corporation; that he has carefully examined the form of contract, notice to bidders, specifications, and has carefully examined classes of materials of the proposed work; and agrees that he will furnish all the materials called for in the contract and specifications in the manner prescribed therein and according to the requirements of the Engineer as therein set forth.

It is understood that the following quantities of work to be done at unit prices are approximate only, and are intended principally to serve as a guide in evaluating bids.

It is further agreed that the quantities of materials to be furnished may be increased or diminished as may be considered necessary, in the opinion of the Engineer, to complete the work fully as planned and contemplated and that all quantities of materials whether increased or decreased are to be furnished at the unit prices set forth as follows:

Accompanying this proposal is a certified or cashier's check or bidders bond payable to the Owner in an amount of not less than five percent of the maximum amount bid. The bid security accompanying this proposal shall be returned to the bidder, unless in case of the proposal the bidder shall fail to execute a contract, in which case the bid security shall become the property of the Owner, and shall be considered as payment for damages due to delay and other inconveniences suffered by the Owner on account of such failure of the bidder. It is understood that the Owner reserves the right to reject any and all bids. It is also understood that the Owner reserves the right to reject informalities in the bid proposal.

The undersigned bidder hereby proposes to perform the following work at the following unit prices to wit:

PROPOSAL
for
2023 Texas Community Development Block Grant
TxCDBG No.: CDB23-0112
Paving and Drainage Improvements
Knox City, Knox County, Texas

NOTE: Bids will be disqualified if the unit quantity cost of any line item is not completed.

BASE BID

ITEM NO	ESTIMATED QUANTITY	DESCRIPTION AND UNIT PRICE (Price to be written in words)	UNIT PRICE	TOTAL PRICE
1	1 LS	Mobilization, Bonds, and Insurance (not to exceed 5% of total base bid), for _____ _____ _____ Dollars and _____ Cents per lump sum.		\$ _____
2	1 LS	Furnish and install erosion control measures, Plan and Implementation, and all related work, as shown and as specified, for _____ _____ _____ Dollars and _____ Cents per lump sum.		\$ _____
3	1 LS	Prepare, and Implement Traffic Control Plan, Plan and Implementation, and all related work, as specified, for _____ _____ _____ Dollars and _____ Cents per lump sum.		\$ _____
4	2,990 SY	Remove and dispose of existing Base and Asphaltic Pavement, and all related work, as shown and as specified, for _____ _____ _____ Dollars and _____ Cents per square yard.	\$ _____ /SY	\$ _____
5	2,990 SY	Furnish and install Flexible Base Material (6" Thick), and all related work, as shown and as specified, for _____ _____ _____ Dollars and _____ Cents per square yard.	\$ _____ /SY	\$ _____
6	1,200 GAL	Furnish and install Prime Coat, (CCS-1H) (0.40 GAL/SY) and all related work, as shown and as specified, for _____ _____ _____ Dollars and _____ Cents per gallon.	\$ _____ /GAL	\$ _____

ITEM NO	ESTIMATED QUANTITY	DESCRIPTION AND UNIT PRICE (Price to be written in words)	UNIT PRICE	TOTAL PRICE
7	350 TON	Furnish and install HMAC Type "D" (2") (PG 70-22), and all related work as shown and as specified, complete and in place, for _____ Dollars and _____ Cents per ton.	\$ _____ /TON	\$ _____
8	200 SY	Furnish and install gravel driveway repair complete and in place, as shown and as specified, for _____ Dollars and _____ Cents per square yard.	\$ _____ /SY	\$ _____
9	2 EA	Furnish and install valve height adjustment, and all related work as shown and as specified, for _____ Dollars and _____ Cents per each.	\$ _____ /EA	\$ _____
10	1 EA	Furnish and install concrete water valve collar, and all related work as shown and as specified, for _____ Dollars and _____ Cents per each.	\$ _____ /EA	\$ _____
11	1862 LF	Furnish and install right-of-way restoration and grading to re-establish existing stormwater drainage, complete and in place, as shown and as specified, for _____ Dollars and _____ Cents per linear foot.	\$ _____ /LF	\$ _____
TOTAL BASE BID (Items 1 thru 11)			\$ _____	

ALT BID 1

ITEM NO	ESTIMATED QUANTITY	DESCRIPTION AND UNIT PRICE (Price to be written in words)	UNIT PRICE	TOTAL PRICE
1-1	2 EA	Rehabilitate and Clean existing concrete culverts, reestablish stormwater drainage, and all related work, as shown and as specified, for _____ Dollars and _____ Cents per each.	\$ _____ /EA	\$ _____
TOTAL ALT BID 1 (Item 1-1)			\$ _____	

ALT BID 2 – NE. 2ND ST.

ITEM NO	ESTIMATED QUANTITY	DESCRIPTION AND UNIT PRICE (Price to be written in words)	UNIT PRICE	TOTAL PRICE
2-1	1 LS	Prepare and Implement Traffic Control Plan, and all related work, as specified, for _____ Dollars and _____ Cents per lump sum.		\$ _____
2-2	810 SY	Remove existing Base and Asphaltic Pavement, dispose of excess material, and all related work, as shown and as specified, for _____ Dollars and _____ Cents per square yard.	\$ _____ /SY	\$ _____
2-3	810 SY	Furnish and install Flexible Base Material (6" Thick), and all related work, as shown and as specified, for _____ Dollars and _____ Cents per square yard.	\$ _____ /SY	\$ _____
2-4	324 GAL	Furnish and install Prime Coat, (CCS-1H) (0.40 GAL/SY) and all related work, as shown and as specified, for _____ Dollars and _____ Cents per gallon.	\$ _____ /GAL	\$ _____
2-5	95 TON	Furnish and install HMAC Type "D" (2") (PG 70-22), and all related work as shown and as specified, complete and in place, for _____ Dollars and _____ Cents per ton.	\$ _____ /TON	\$ _____
2-6	60 SY	Furnish and install gravel driveway repair complete and in place, as shown and as specified, for _____ Dollars and _____ Cents per square yard.	\$ _____ /SY	\$ _____
2-7	626 LF	Furnish and install right-of-way restoration and grading to re-establish existing stormwater drainage, complete and in place, as shown and as specified, for _____ Dollars and _____ Cents per linear foot.	\$ _____ /LF	\$ _____
TOTAL ALT BID 2 (Items 2-1 thru 2-7)			\$ _____	

ALT BID 3 – NE. 3rd ST.

ITEM NO	ESTIMATED QUANTITY	DESCRIPTION AND UNIT PRICE (Price to be written in words)	UNIT PRICE	TOTAL PRICE
3-1	1 LS	Prepare, and Implement Traffic Control Plan, and all related work, as specified, for _____ Dollars and _____ Cents per lump sum.		\$ _____
3-2	1,580 SY	Remove existing Base and Asphaltic Pavement, dispose of excess material, and all related work, as shown and as specified, for _____ Dollars and _____ Cents per square yard.	\$ _____ /SY	\$ _____
3-3	1,580 SY	Furnish and install Flexible Base Material (6" Thick), and all related work, as shown and as specified, for _____ Dollars and _____ Cents per square yard.	\$ _____ /SY	\$ _____
3-4	632 GAL	Furnish and install Prime Coat, (CCS-1H) (0.40 GAL/SY) and all related work, as shown and as specified, for _____ Dollars and _____ Cents per gallon.	\$ _____ /GAL	\$ _____
3-5	182 TON	Furnish and install HMAC Type "D" (2") (PG 70-22), and all related work as shown and as specified, complete and in place, for _____ Dollars and _____ Cents per ton.	\$ _____ /TON	\$ _____
3-6	110 SY	Furnish and install gravel driveway repair complete and in place, as shown and as specified, for _____ Dollars and _____ Cents per square yard.	\$ _____ /SY	\$ _____
3-7	1 EA	Furnish and install valve height adjustment, and all related work as shown and as specified, for _____ Dollars and _____ Cents per each.	\$ _____ /EA	\$ _____
3-8	1 EA	Furnish and install concrete water valve collar, and all related work as shown and as specified, for _____ Dollars and _____ Cents per each.	\$ _____ /EA	\$ _____

ITEM NO	ESTIMATED QUANTITY	DESCRIPTION AND UNIT PRICE (Price to be written in words)	UNIT PRICE	TOTAL PRICE
3-9	1,206 LF	Furnish and install right-of-way restoration and grading to re-establish existing stormwater drainage, complete and in place, as shown and as specified, for _____ _____ _____ Dollars and _____ Cents per linear foot.	\$ _____ /LF	\$ _____
TOTAL ALT BID 3 (Items 3-1 thru 3-9)			\$ _____	

ALT BID 4 – NE. 4th ST.

ITEM NO	ESTIMATED QUANTITY	DESCRIPTION AND UNIT PRICE (Price to be written in words)	UNIT PRICE	TOTAL PRICE
4-1	1 LS	Prepare, and Implement Traffic Control Plan, and all related work, as specified, for _____ _____ _____ Dollars and _____ Cents per lump sum.		\$ _____
4-2	1,470 SY	Remove existing Base and Asphaltic Pavement, Dispose of excess material, and all related work, as shown and as specified, for _____ _____ _____ Dollars and _____ Cents per square yard.	\$ _____ /SY	\$ _____
4-3	1,470 SY	Furnish and install Flexible Base Material (6" Thick), and all related work, as shown and as specified, for _____ _____ _____ Dollars and _____ Cents per square yard.	\$ _____ /SY	\$ _____
4-4	590 GAL	Furnish and install Prime Coat, (CCS-1H) (0.40 GAL/SY) and all related work, as shown and as specified, for _____ _____ _____ Dollars and _____ Cents per gallon.	\$ _____ /GAL	\$ _____
4-5	170 TON	Furnish and install HMAC Type "D" (2") (PG 70-22), and all related work as shown and as specified, complete and in place, for _____ _____ _____ Dollars and _____ Cents per ton.	\$ _____ /TON	\$ _____

ITEM NO	ESTIMATED QUANTITY	DESCRIPTION AND UNIT PRICE (Price to be written in words)	UNIT PRICE	TOTAL PRICE
4-6	130 SY	Furnish and install gravel driveway repair complete and in place, as shown and as specified, for _____ Dollars and _____ Cents per square yard.	\$ _____ /SY	\$ _____
4-7	1,220 LF	Furnish and install right-of-way restoration and grading to re-establish existing stormwater drainage, complete and in place, as shown and as specified, for _____ Dollars and _____ Cents per linear foot.	\$ _____ /LF	\$ _____
TOTAL ALT BID 4 (Items 4-1 thru 4-7)			\$ _____	

Bids may be held by the City of Knox City for a period not to exceed 60 days from the date of the bid opening for the purpose of reviewing the bids and investigating the bidders qualifications prior to the contract award.

The undersigned bidder agrees that he will furnish and install all materials within _____ () days after the date of the "Notice to Proceed".

The undersigned bidder estimates that he will be able to start work on this project on or about _____.


The materials shall be accepted when delivered to the Owner in accordance with the specifications, to the satisfaction of the Engineer.

The undersigned certifies that the bid prices contained in the proposal have been carefully checked and are submitted as correct and final.

NOTE: The prices must be shown in words and figures in the proposal and in the event of discrepancy, the words shall control.

Receipt is hereby acknowledged of addenda to the contract documents number _____.


*		*
*	Mailing Address and Zip Code	BIDDER:_____*
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*	Email Address	*
*		*
*	_____	_____*
*	Area Code and Telephone Number	Name of Person Signing Bid _____*
*		*
*		*
*	_____	_____*
*	Federal I.D. Number/Social Security	Title _____*

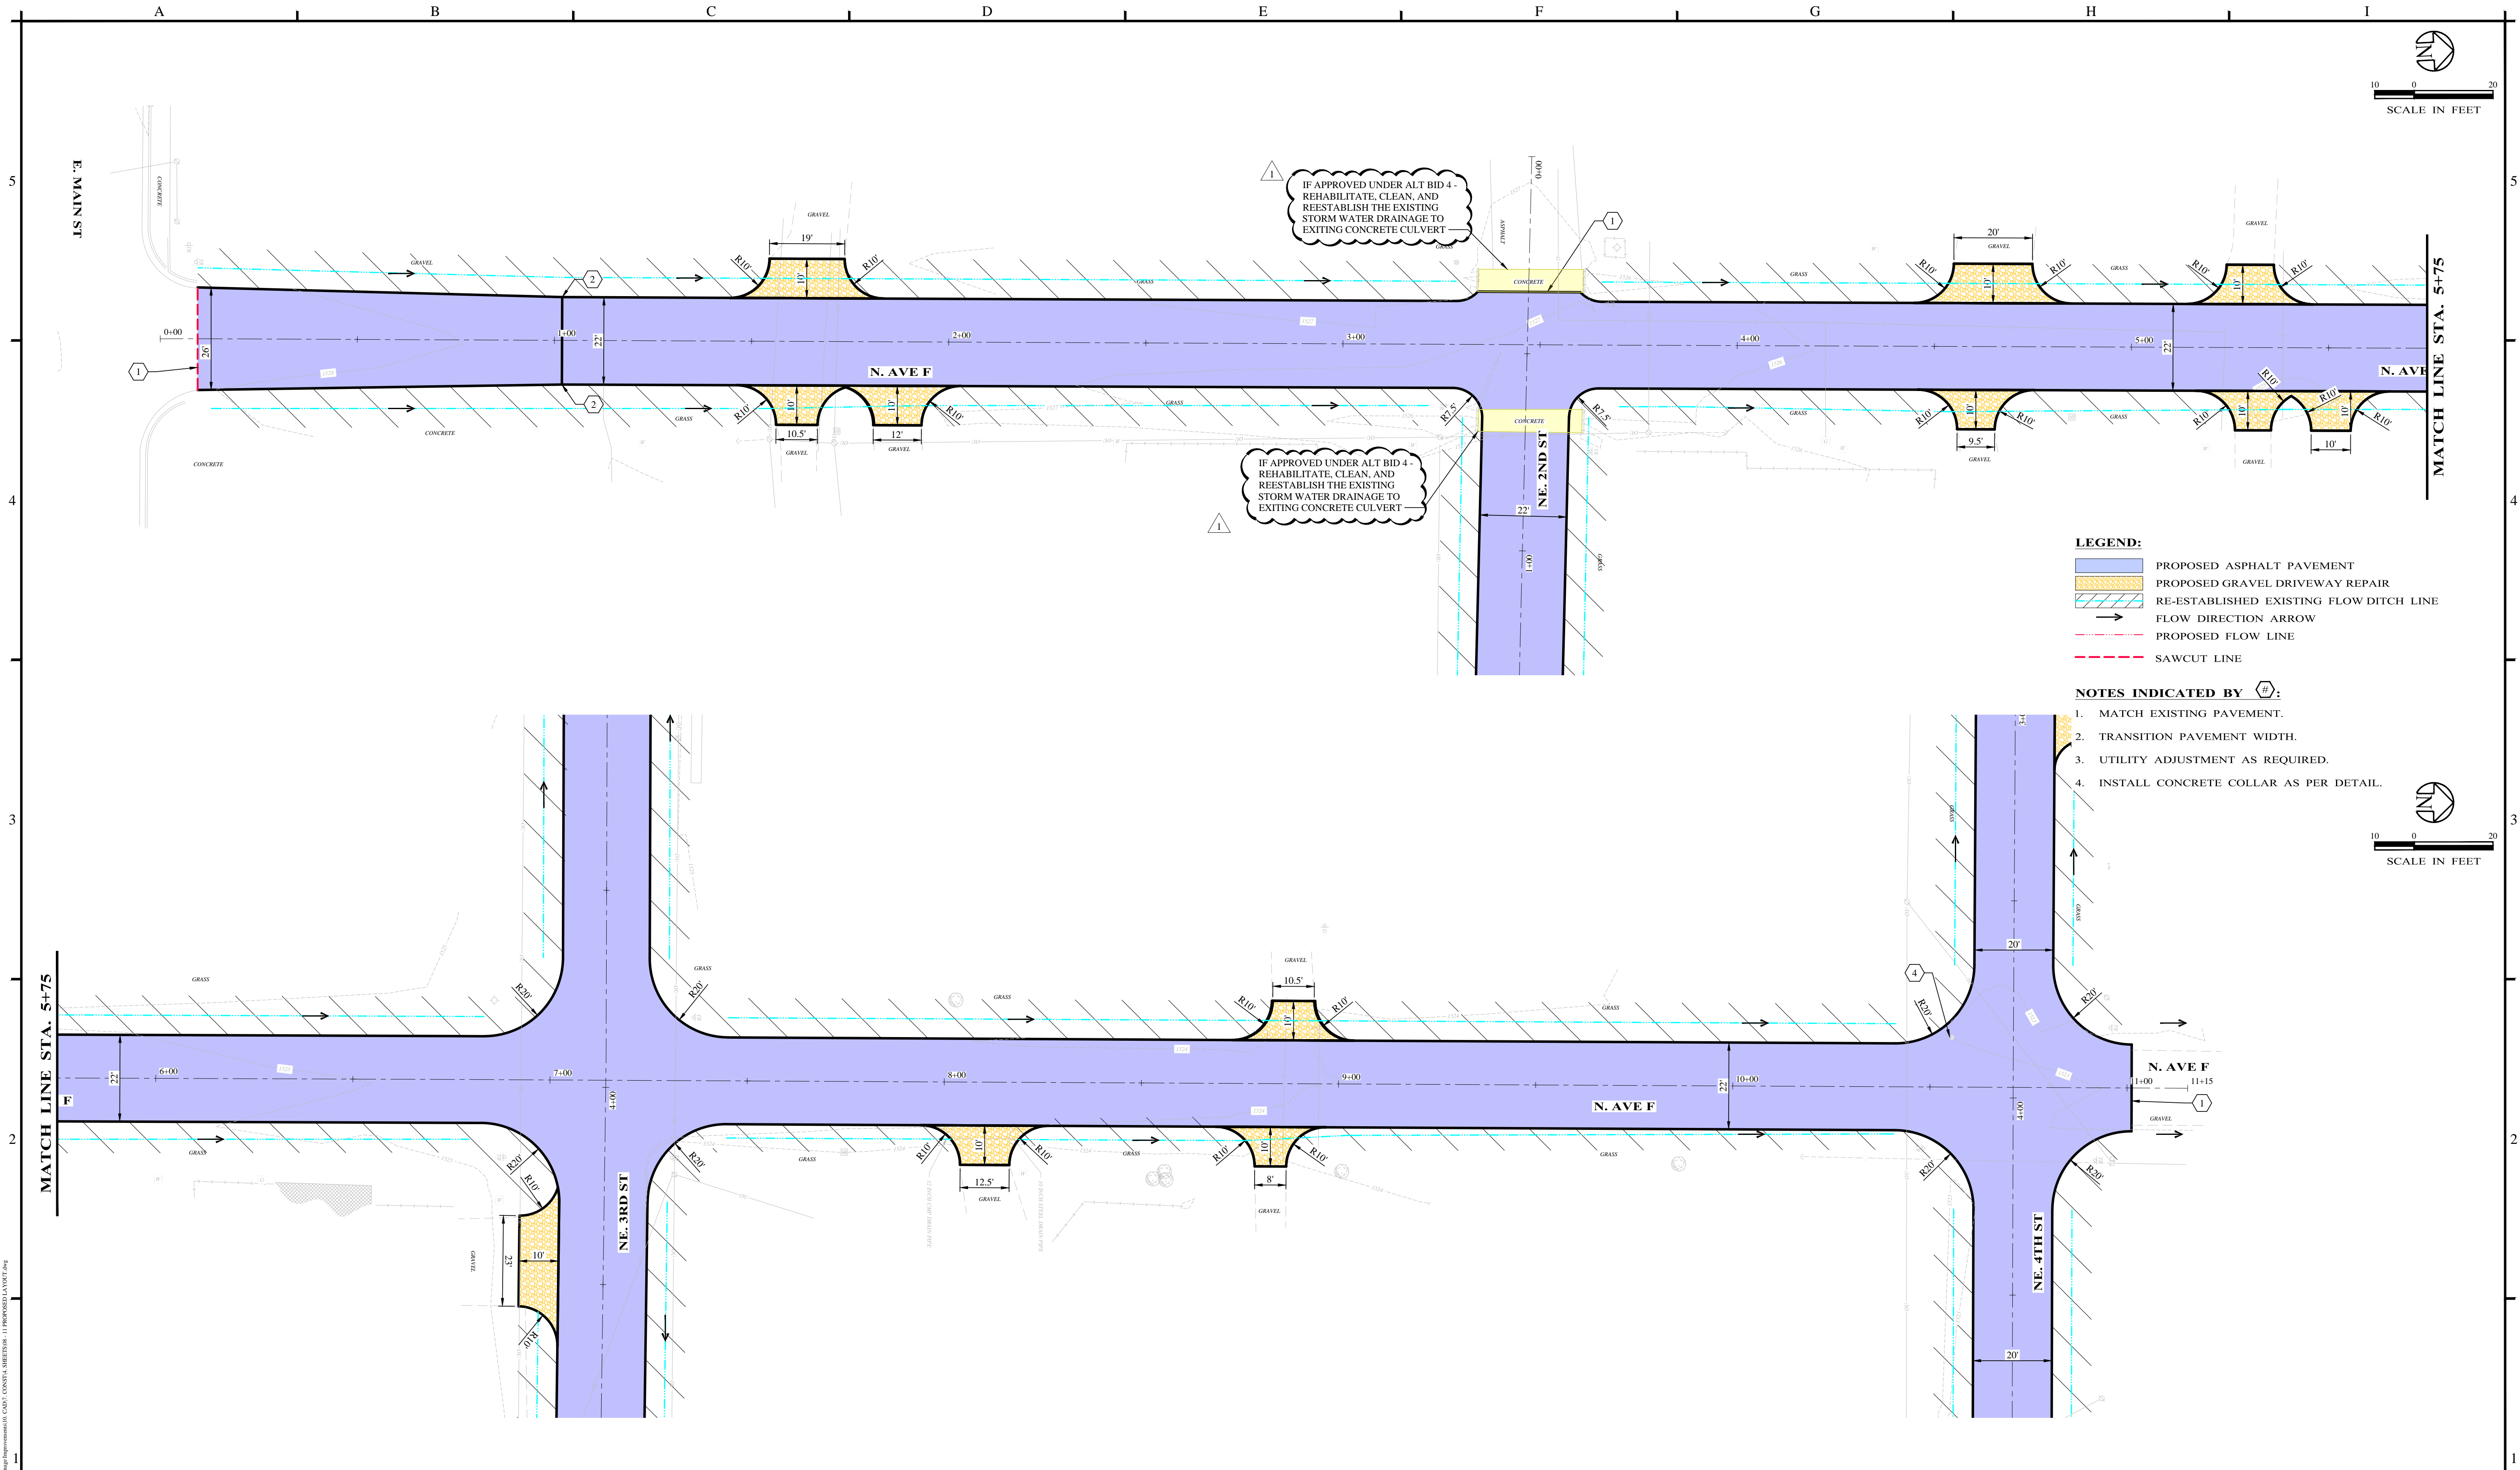

- LEGEND:**
- PROPOSED ASPHALT PAVEMENT
 - PROPOSED GRAVEL DRIVEWAY REPAIR
 - RE-ESTABLISHED EXISTING FLOW DITCH LINE
 - FLOW DIRECTION ARROW
 - PROPOSED FLOW LINE
 - SAWCUT LINE

- NOTES INDICATED BY (#):**
- MATCH EXISTING PAVEMENT.
 - TRANSITION PAVEMENT WIDTH.
 - UTILITY ADJUSTMENT AS REQUIRED.
 - INSTALL CONCRETE COLLAR AS PER DETAIL.

<table><tr><td>NO.</td><td>REVISION</td><td>DATE</td></tr><tr><td>1</td><td>ADDENDUM 3</td><td>12/31/2025</td></tr></table>		NO.	REVISION	DATE	1	ADDENDUM 3	12/31/2025	11/14/2025		 402 Cedar Street • Abilene, Texas 79601 • T: (325) 698-5560 • F: (325) 690-3240 • www.e-ht.com PE Firm Registration No. 1151 • PG Firm Registration No. 50103 • RPLS Firm Registration No. 10011900	<p>BAR IS ONE INCH ON ORIGINAL DRAWING</p> <p>IF NOT ONE INCH ON THIS SHEET, ADJUST SCALES ACCORDINGLY.</p>	<p>DISCLAIMER:</p> <p>THIS DRAWING IS INTENDED TO BE PRINTED IN COLOR!</p>	<table><tr><td>DESIGNED BY J. BURCHAM</td><td>SCALE HOR : 1" = 20' VERT : 1" = 5'</td></tr><tr><td>DRAWN BY JR. SALINAS</td><td>DATE 11/14/2025</td></tr><tr><td>CHECKED BY S. DILLER</td><td></td></tr></table>	DESIGNED BY J. BURCHAM	SCALE HOR : 1" = 20' VERT : 1" = 5'	DRAWN BY JR. SALINAS	DATE 11/14/2025	CHECKED BY S. DILLER		<table><tr><td colspan="2">PAVING & DRAINAGE IMPROVEMENTS KNOX CITY, KNOX COUNTY, TEXAS</td><td>PROJECT NO.: 9076</td></tr><tr><td colspan="2">BASE BID - NORTH AVENUE F PROPOSED LAYOUT</td><td>SHEET No. 08</td></tr></table>	PAVING & DRAINAGE IMPROVEMENTS KNOX CITY, KNOX COUNTY, TEXAS		PROJECT NO.: 9076	BASE BID - NORTH AVENUE F PROPOSED LAYOUT		SHEET No. 08
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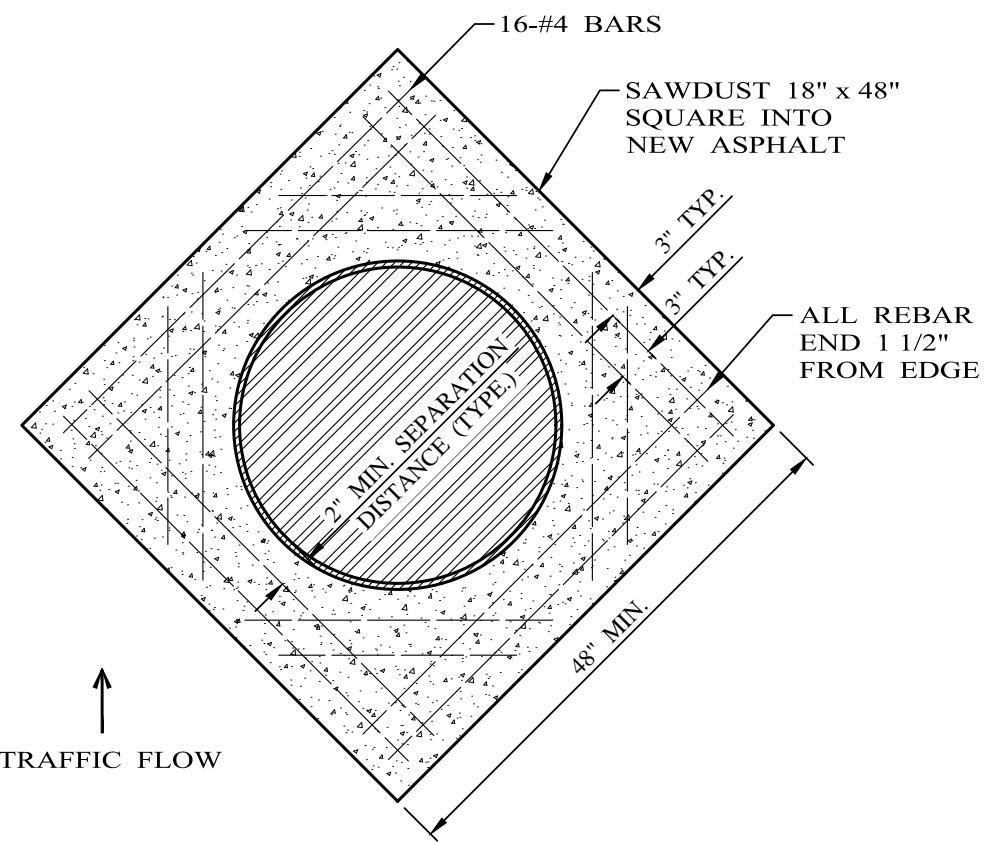


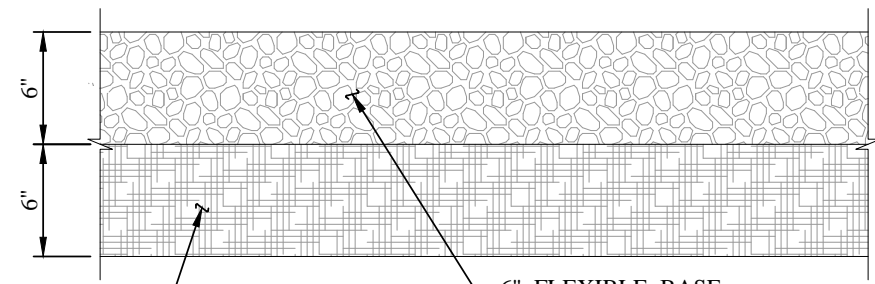6" FLEXIBLE BASE
MATERIAL PER ITEM 247,
TYPE A, GRADE 1
COMPACTED TO 95%
MODIFIED PROCTOR PER
ASTM 1557.


SUBGRADE SHALL BE UNIFORMLY COMPACTED TO A MINIMUM OF
95% STANDARD PROCTOR DENSITY BETWEEN -1 AND +3
PERCENTAGE POINTS OF OPTIMUM MOISTURE CONTENT IN
ACCORDANCE WITH ASTM D698. SUBGRADE SHALL EXTEND A
MINIMUM OF ONE (1) FOOT BEYOND THE EDGE OF PAVEMENT.

TYPICAL GRAVEL DRIVEWAY DETAIL

NO SCALE



PLAN VIEW

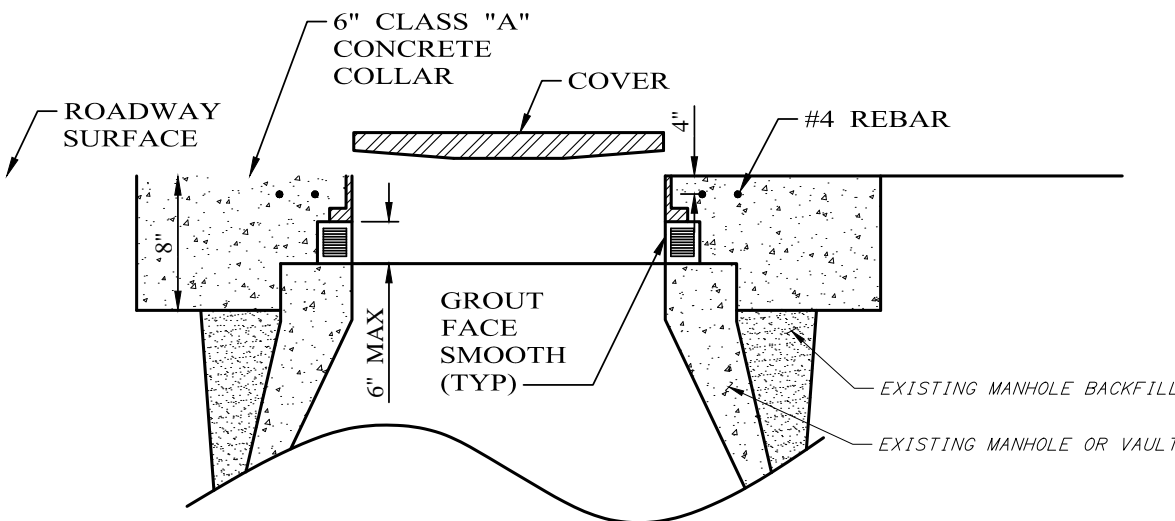



SECTION VIEW

NOTES:

1. ADJUST MANHOLE LID TO BE FLUSH WITH FINISHED GRADE TO 1/4" BELOW FINISHED GRADE OF FINAL ASPHALT PAVEMENT.
2. IF GRADE RINGS ARE USED, THEY SHALL NOT BE USED TO A DEPTH GREATER THAN 6".
3. WATER VALVES THAT HAVE EXISTING CONCRETE COLLARS SHALL HAVE THE EXISTING COLLAR REMOVED AND REPLACED AT THE NEW GRADE.

MANHOLE COLLAR DETAIL


NO SCALE

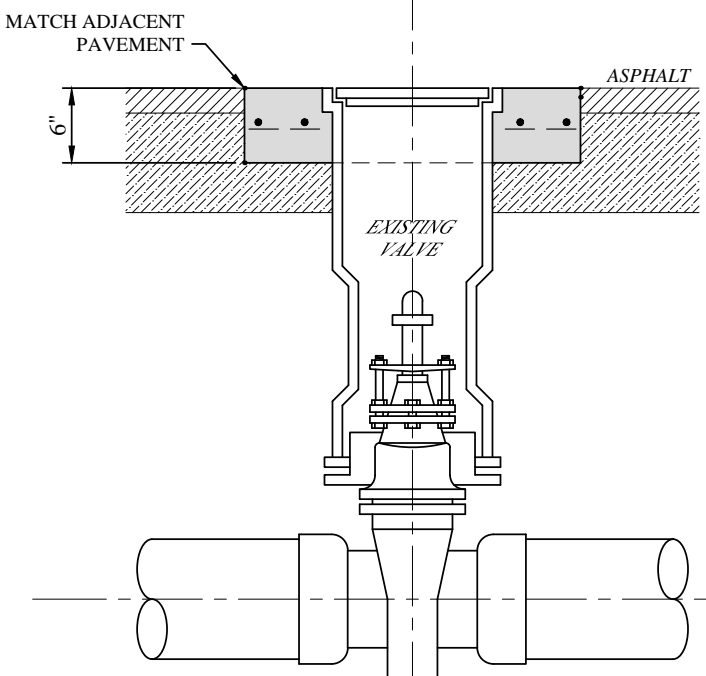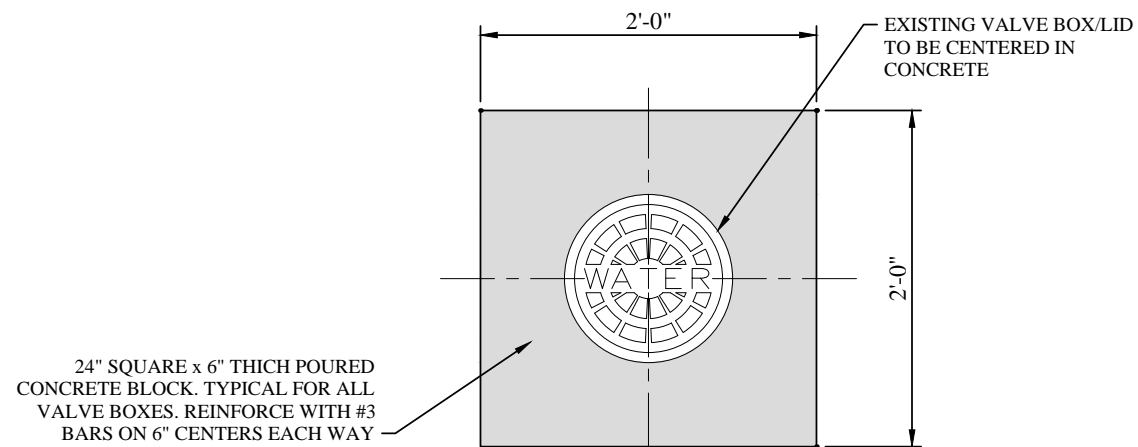

VALVE BOX ADJUSTMENT DETAIL

NO SCALE

**ASPHALTIC HOT MIX PAVING IS DEPENDENT ON THE
WEATHER. IT IS ANTICIPATED CONSTRUCTION
WOULD NOT START UNTIL MARCH 1, 2026**

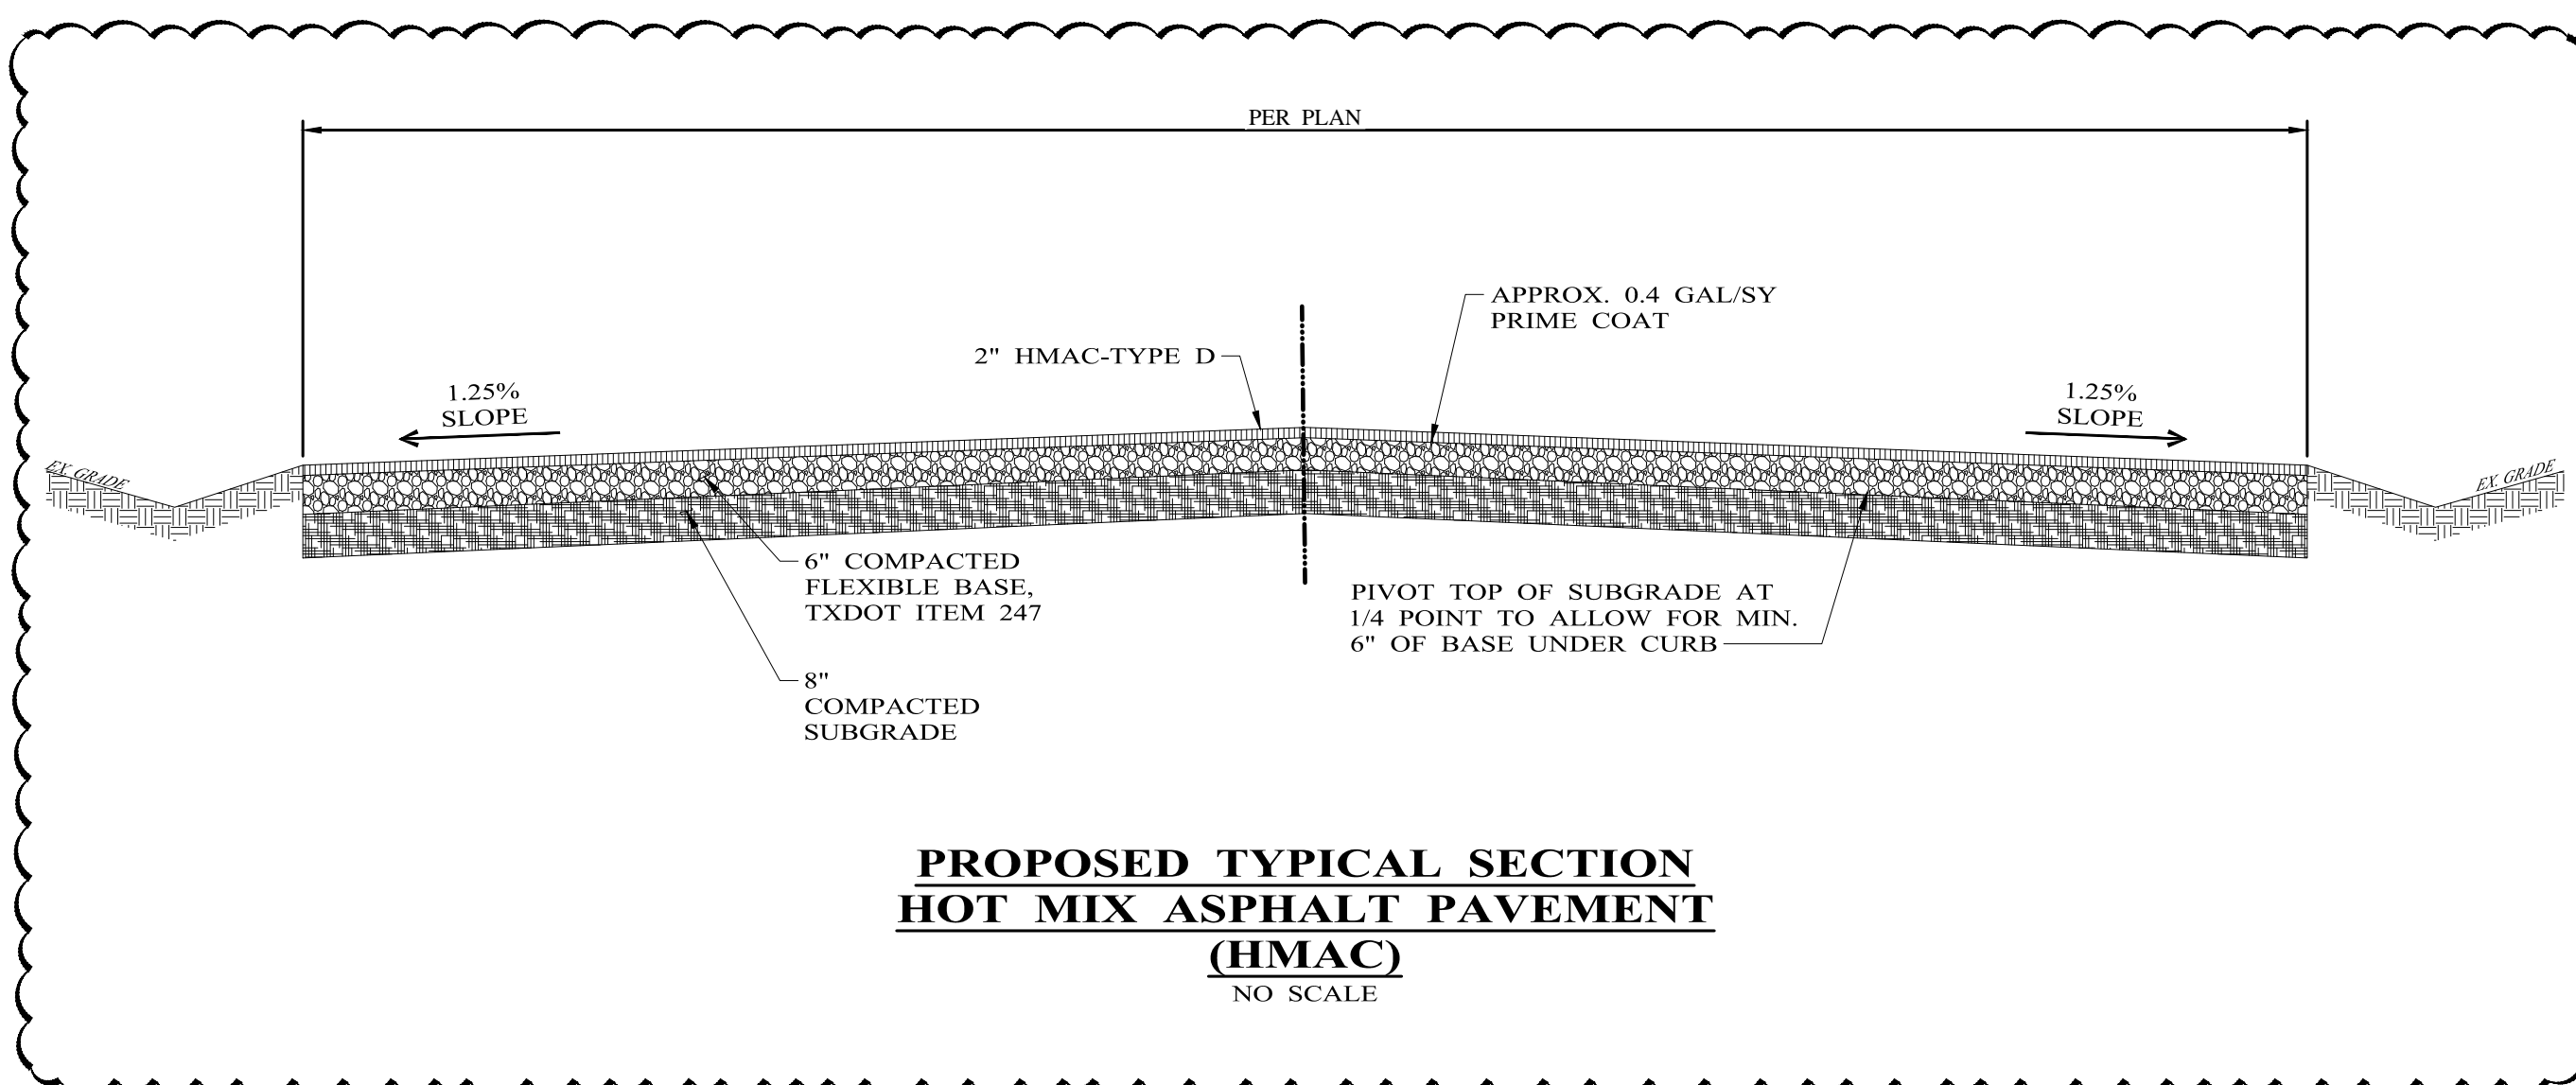

**PROPOSED TYPICAL SECTION
HOT MIX ASPHALT PAVEMENT
(HMAC)**

NO SCALE

NO.	REVISION	DATE	11/14/2025
1	ADDENDUM 3	12/31/2025	



Enprotec | Hibbs & Todd
402 Cedar Street • Abilene, Texas 79601 • T: (325) 698-5560 • F: (325) 690-3240 • www.e-ht.com
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IF NOT ONE INCH ON
THIS SHEET, ADJUST
SCALES ACCORDINGLY.

DISCLAIMER:
**THIS DRAWING
IS INTENDED TO
BE PRINTED IN
COLOR !**

DESIGNED BY
J. BURCHAM
DRAWN BY
JR. SALINAS
CHECKED BY
S. DILLER

SCALE
NO SCALE
DATE
11/14/2025

**PAVING & DRAINAGE IMPROVEMENTS
KNOX CITY, KNOX COUNTY, TEXAS**

DETAILS

PROJECT NO.:
9076
SHEET No.
12